

## **GREENACRE ROAD**

 $\left(\begin{array}{c}3\end{array}\right)$ 

DIAL 1100 BEFORE YOU DIG

Rev	Date	AMENDMENTS	Rev.	Date	AMENDMENTS

ENTRY

BOUNDARY 11.125m

M.Noaman BE MIE (Aust) PROPOSED COMMUNITY CENTER CONSULTING ENGINEER- STRUCTURAL & CIVIL SHOP 2/27-29 MARY STREET, AUBURN, NSW 2144 FAX: 02-9602 5434 MOBILE 0405 581110 email: austiplex@consultant.com

AT 68 WATERLOO ROAD , GREENACRE, NSW


Design: M.Noaman Drawn: MN Scale: 1:100

DA02/4 PROJECT No.

ESD02-11/20SW Date: Nov 2020 Issue A


Drawing:
UPPER BASEMENT DRAINAGE PLAN **ECO-SPACE DESIGN** 


Check a	ll dimensions on site before commencing work, report
any dis	repancies to consultant for clarification. Do not scale
	e drawings. This drawing is copyright and remains the
	of the Consultants and must not be used, copied or
	ed in whole or part except by agreement with the

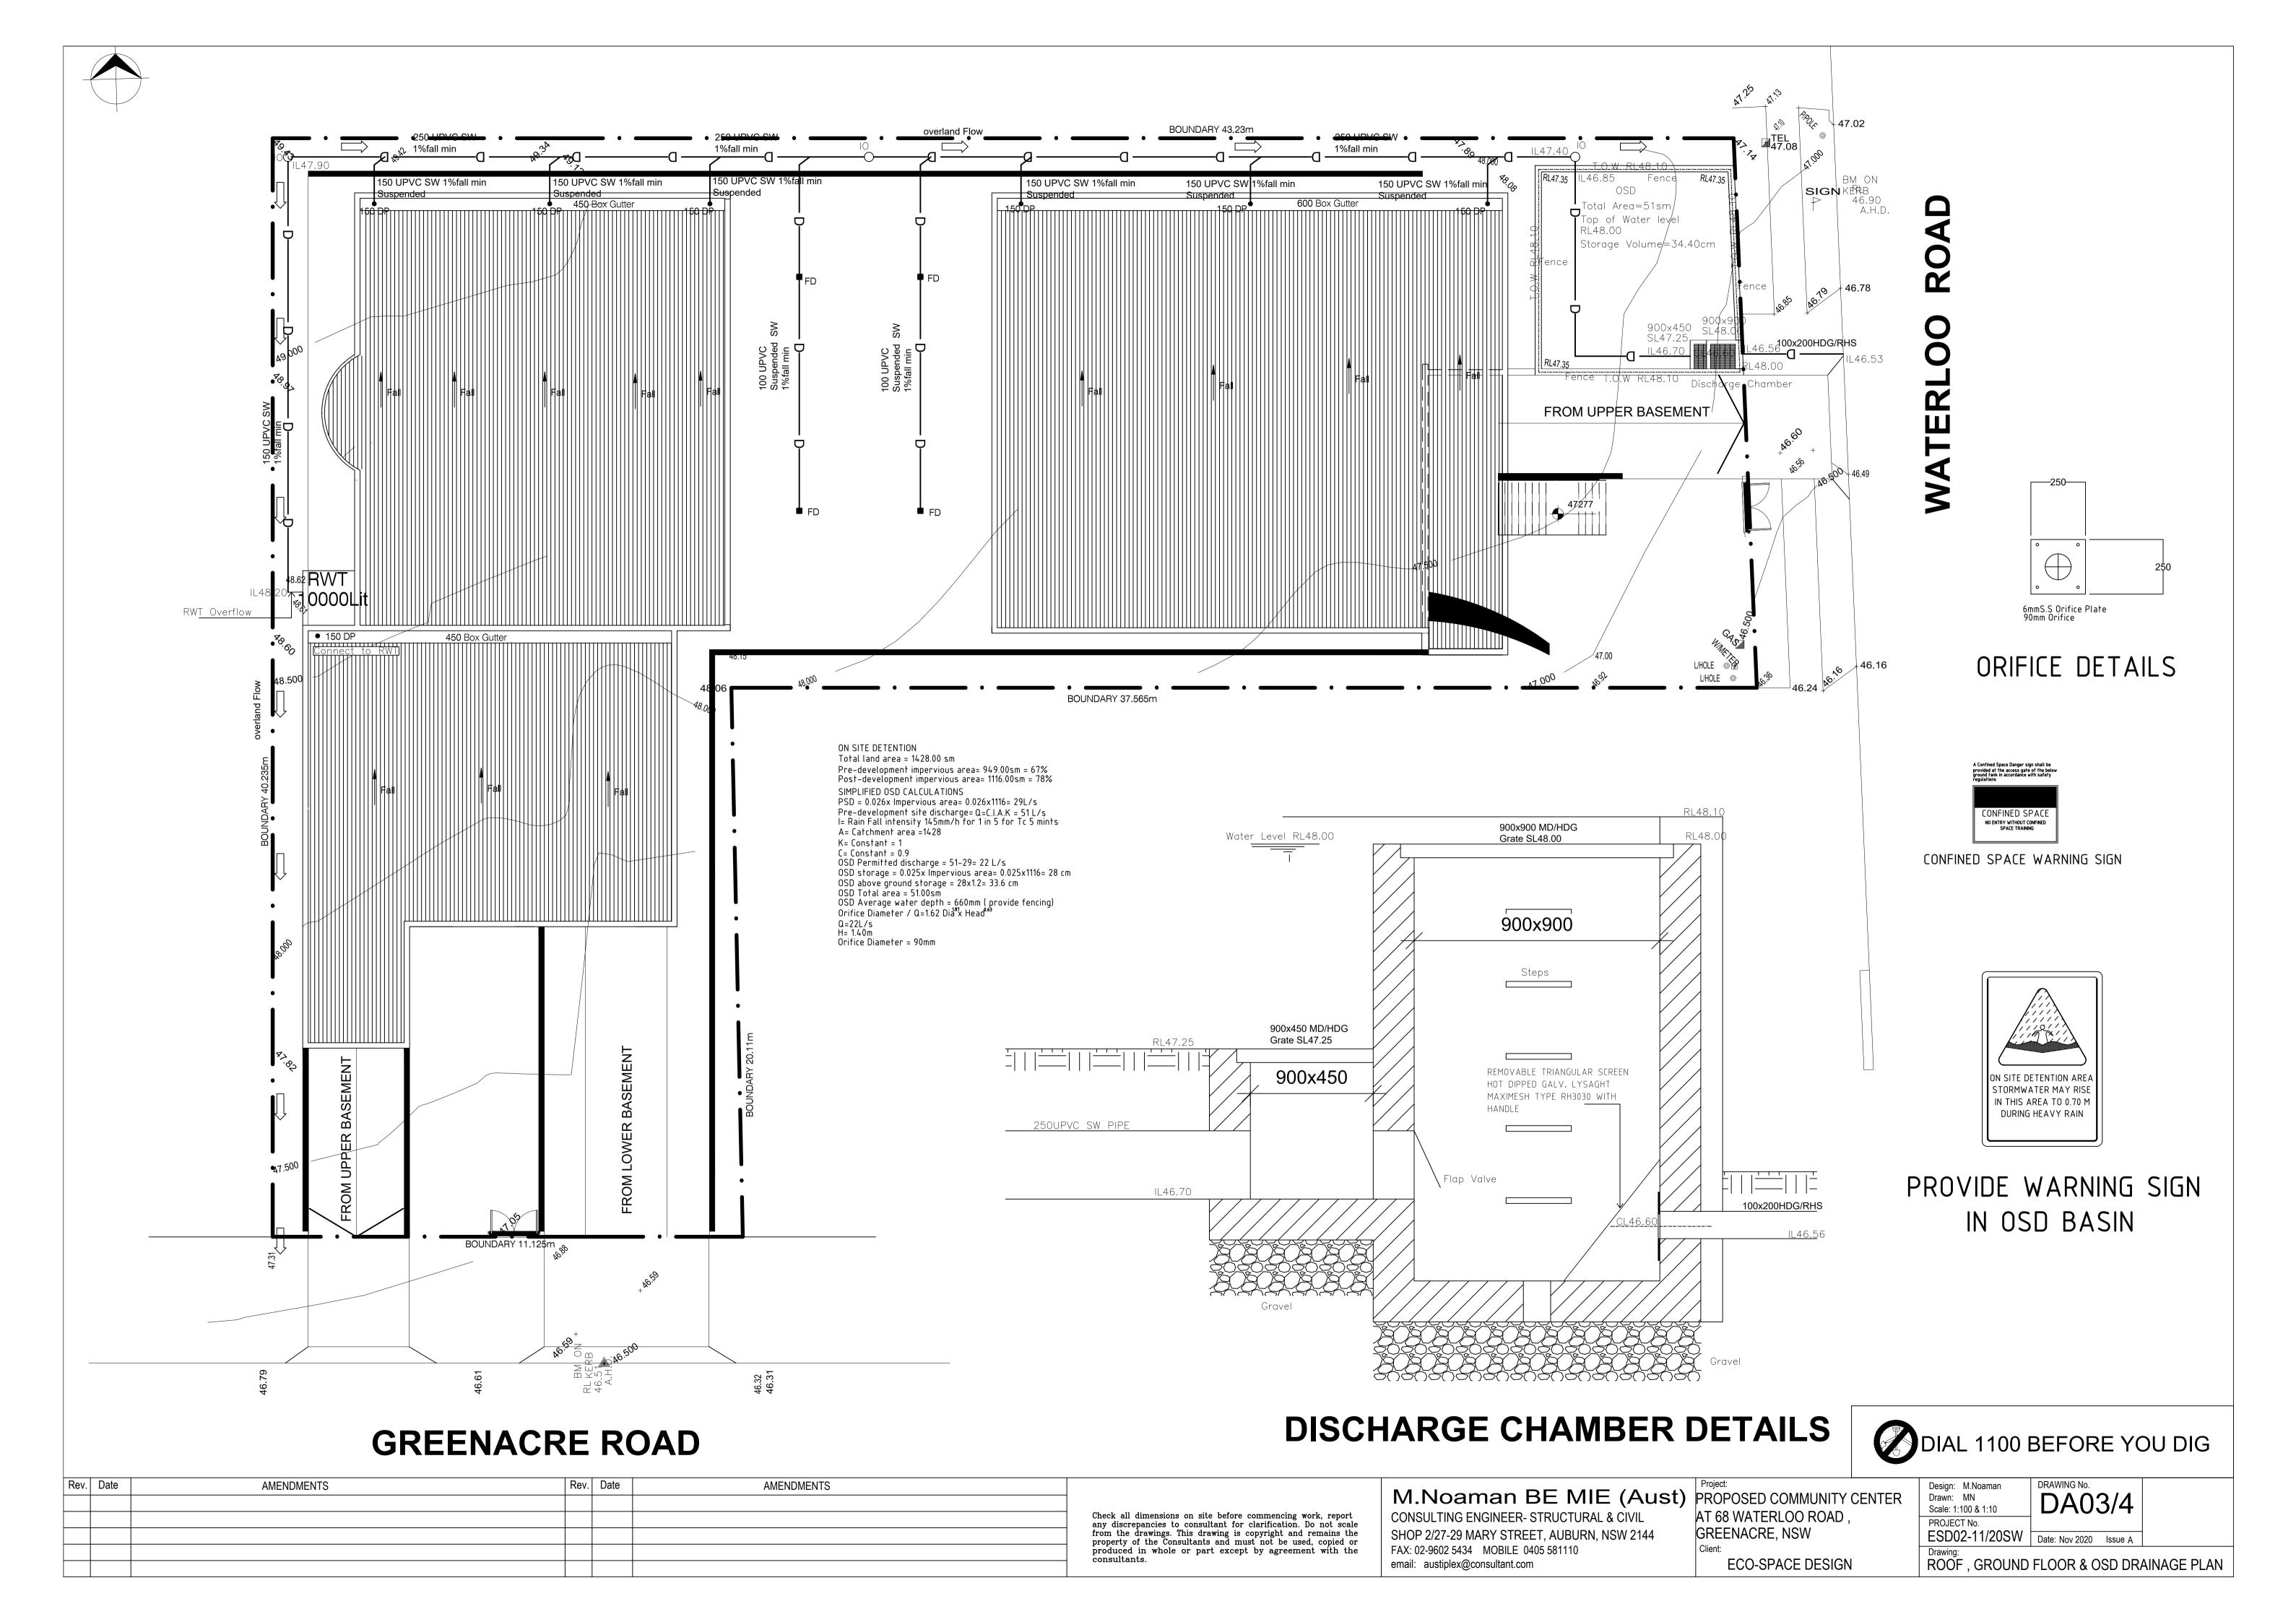




### LEGEND

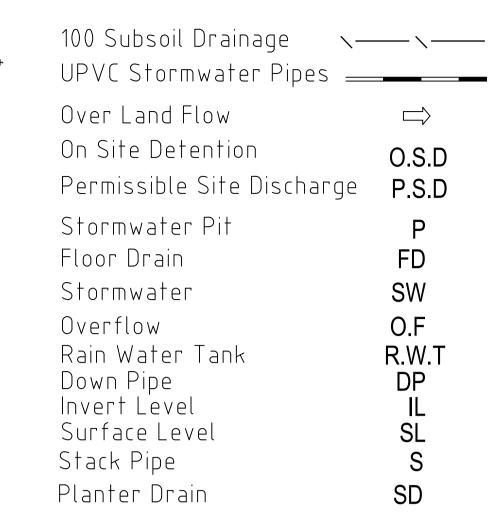

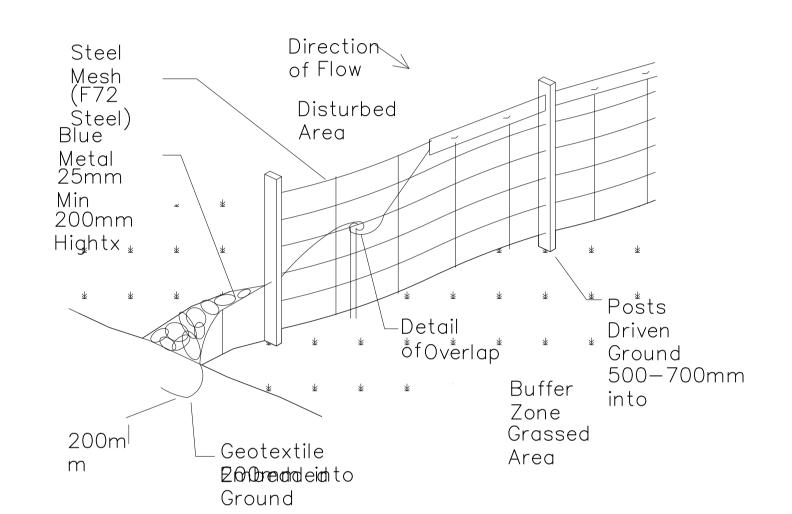

### SEDIMENT FENCE N.T.S

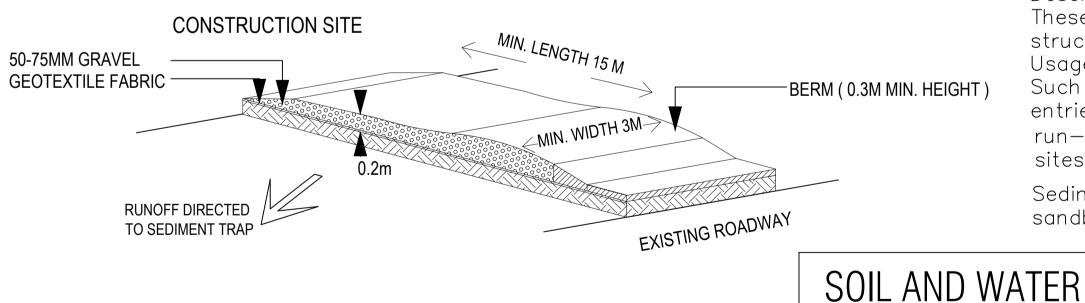

## TEMPORARY CONSTRUCTION EXIT / ENTRANCE N.T.S.

TEMPORARY 1.8M HIGH WIRE MESH FENCE WITH DUSTPROOF MESH APPLIED TO FULL HEIGHTTO BOUNDARIES AS REQUIRED

LOCATION OF WASTE BINS

SEDIMENT FENCE AS REQUIRED GRAVEL ACCESS

SITE ACCESS AREA TO BE USED FOR WASHDOWN AREA

FOOTPATH CLEAN AND CLEAR AT ALL TIMES

LOCATION OF STOCKPILE MATERIAL MATERIAL STORAGE AREA TEMPORARY TOILETS INSTALL TEMPORARY SEDIMENT BARRIERS TO ALL INLET PITS LIKELY

TO COLLECT SILT LADDEN WATER, TO

COUNCILS'S REQUIREMENTS.

03. ALL STOCKPILES TO BE CLEAR FROM DRAINS, GUTTERS AND FOOTPATHS.

> 04. DRAINAGE TO BE CONNECTED TO STORMWATER SYSTEM AS SOON AS POSSIBLE.

MANAGEMENT NOTES

DAILY BY SITE MANAGER

02. MINIMISE DISTURBED AREAS

01. ALL EROSION AND SEDIMENT CONTROL

MEASURES TO BE INSPECTED AND MAINTAINED

Location of

Grated Inlet

-sausage

Plan

50mm Gap to

Water Access

(sausage)

Description

Installation

Blue metal groyne

fabric, some 200mm

Generally the sausage

closed both ends.

diameter, filled with 25mm blue metal and

Direction

Storm inlet sediment

entries and points where

sandbags (or sarlon type

sites is discharged.

These are temporary de-silting

trap (n.t.s.)

Description

structures.

Usage

Allow

to Pit

A Sausage of Coarse

Metal BLue

The groyne comprises a sausage of shade cloth or other previous

The sausage is laid on the ground on the contour similar to a silt fence.

Filter Cloth Filled with 25mm

05. ROADS AND FOOTPATHS TO BE SWEPT DAILY AND KEPT CLEAN AT ALL TIMES

Stakes

Ground

into

Such sediment traps are used at stormwater inlets and outlets, culvert

Sediment traps are built from straw bales, washed gravel, gabions or

run—off from disturbed catchments such as construction

Driven 500-700mm

√25mm

Direction

200mmin

Blue Metal to


06. INSTALL TEMPORARY SEDIMENT BARRIERS TO ALL INLET PITS LIKELY TO COLLECT SILT LADDEN WATER, TO COUNCILS'S REQUIREMENTS.

07. NOT WITHSTANDING DETAILS SHOWN, IT IS THE SITE MANAGERS SOLE RESPONSIBILITY TO ENSURE THAT ALL SITE ACTIVITIES COMPLY WITH THE REQUIREMENTS OF THE CLEAN WATERS ACT.


produced in whole or part except by agreement with the


REMOVABLE TRIANGULAR SCREEN HOT DIPPED GALV. LYSAGHT MAXIMESH TYPE RH3030 WITH MOUNTING BRACK MULTI PURPOSE FILTER SCREEN


PRODUCT CODE: MMMPS (MASCOT ENGINEERING)

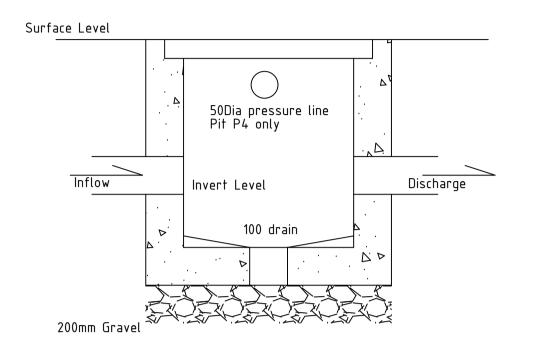

#### SW Pits Standard Details

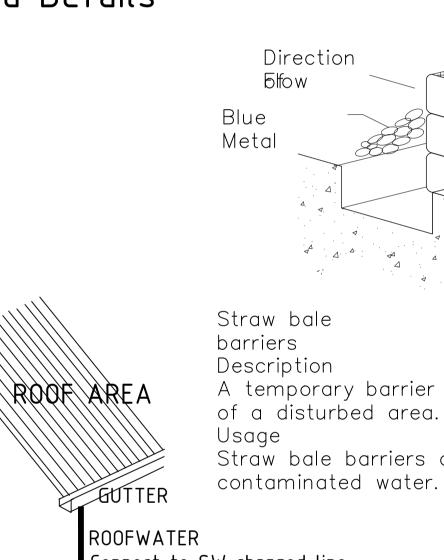


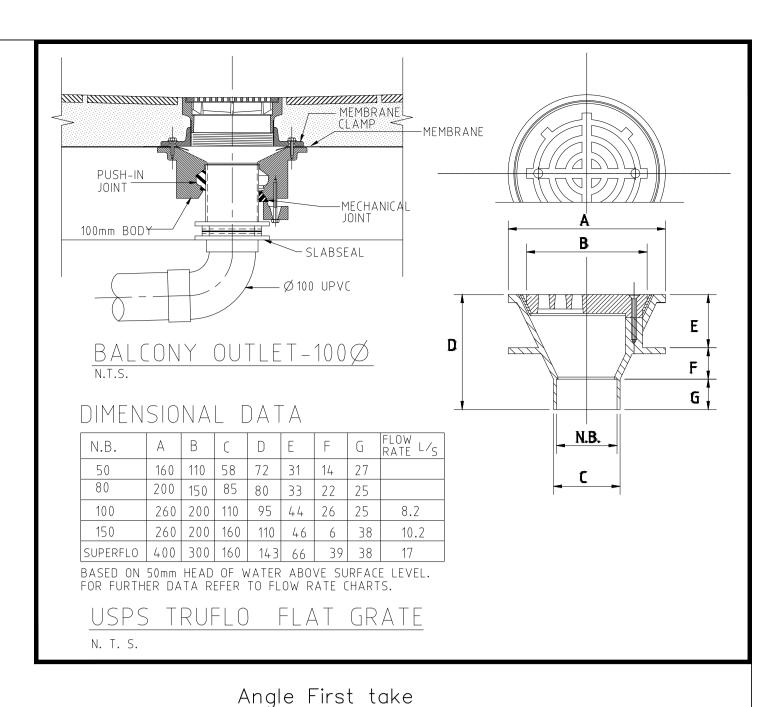

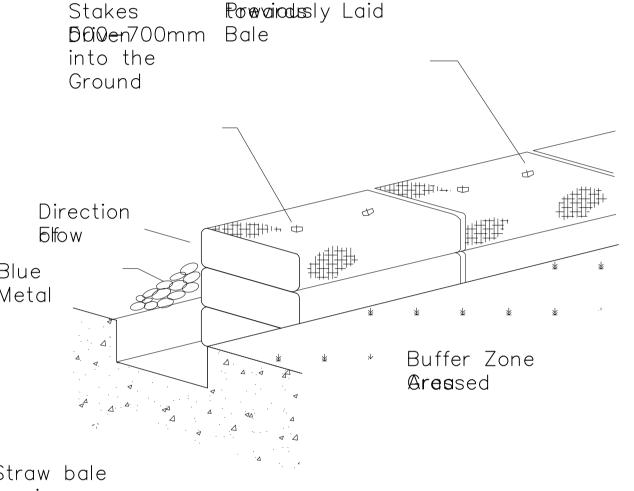

A temporary barrier of straw bales placed around the perimeter

Straw bale barriers are used to desilt

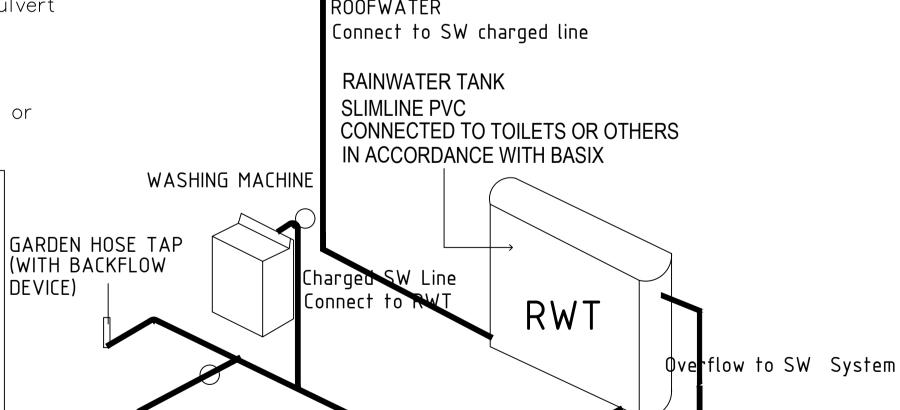

RAINWATER TANK DETAIL

IRRIGATION

SYSTEM

# DIAL 1100 BEFORE YOU DIG

Rev.	Date	AMENDMENTS	Rev. [	Date	AMENDMENTS	

#### M.Noaman BE MIE (Aust) PROPOSED COMMUNITY CENTER Check all dimensions on site before commencing work, report any discrepancies to consultant for clarification. Do not scale from the drawings. This drawing is copyright and remains the property of the Consultants and must not be used, copied or CONSULTING ENGINEER- STRUCTURAL & CIVIL

DEVICE)

SHOP 2/27-29 MARY STREET, AUBURN, NSW 2144 FAX: 02-9602 5434 MOBILE 0405 581110 email: austiplex@consultant.com

AT 68 WATERLOO ROAD,

Design: M.Noaman Drawn: MN Scale: 1:100 & NTS DA04/4 PROJECT No. ESD02-11/20SW | Date: Nov 2020 | Issue A STORMWATER MANAGEMENT PLAN

SCHEMATIC

SW line to street discharge

GREENACRE, NSW **ECO-SPACE DESIGN**